

PROJECT:

LOCATION:

BUILDING TYPE: MSL 26X30

MULTI-RIB ROOF TYPE:

BUILDING NUMBER:

ORDER NUMBER:

QUOTE NUMBER:

DRAWING LIST:

SHEET NUMBER	DRAWING DESCRIPTION
CS	COVER SHEET
1	ARCHITECTURAL ELEVATIONS
2	STRUCTURAL FRAMING PLAN
3	COLUMN LAYOUT



CERTIFICATES: MIAMI-DADE COUNTY CERTIFICATE OF COMPETENCY NO. 21-0819.13 PCI (POWDER COATING INSTITUTE) 4000 CERTIFIED

FABRICATOR APPROVALS: CITY OF PHOENIX, AZ APPROVED FABRICATOR #C08-2010 CITY OF LOS ANGELES, CA APPROVED FABRICATOR #FB01596 CITY OF RIVERSIDE, CA APPROVED FABRICATOR #SF_000042 CITY OF HOUSTON, TX APPROVED FABRICATOR #470 CLARK COUNTY, NV APPROVED FABRICATOR #264 STATE OF UTAH APPROVED FABRICATOR 02008-14 AISC APPROVED FABRICATOR C-00018751



USE FOR PRELIMINARY

PLANNING AND ESTIMATING

ONLY

MATERIALS:

DESCRIPTION TUBE STEEL

SCHEDULE PIPE RMT PIPE LIGHT GAGE COLD FORMED STRUCTURAL STEEL PLATE ROOF PANELS (STEEL)

ASTM DESIGNATION A500 (GRADE B) A53 (GRADE B) A519 A1003 (GRADE 50) A36


A653



GENERAL NOTES: UNLESS NOTED OTHERWISE, THIS STRUCTURE WAS DESIGNED TO ONLY SUPPORT WHAT IS SHOWN ON THESE DRAWINGS. THE MANUFACTURER MUST BE CONTACTED IF ANYTHING ELSE IS TO BE ATTACHED TO THIS STRUCTURE (WALLS, COLUMN WRAPS, RAILINGS, TO DESCIN OF THIS STRUCTURE ON DE DEVIEWED AND ETC.) SO THE DESIGN OF THIS STRUCTURE CAN BE REVIEWED AND POSŚIBLY REVISED.

UNLESS NOTED OTHERWISE, THIS STRUCTURE WAS DESIGNED ASSUMING A 20' SEPARATION BETWEEN ANY ADJACENT STRUCTURE WITH AN EAVE HEIGHT EQUAL TO OR GREATER THAN THE EAVE HEIGHT OF THIS STRUCTURE. IF THAT SEPARATION DOES NOT EXIST, THE MANUFACTURER MUST BE CONTACTED SO THE DESIGN OF THIS STRUCTURE CAN BE REVIEWED AND POSSIBLY REVISED.

STRUCTURAL STEEL SHALL BE DETAILED, FABRICATED, AND ERECTED IN ACCORDANCE WITH THE LATEST EDITION OF THE AMERICAN INSTITUTE OF STEEL CONSTRUCTION (AISC) SPECIFICATION MANUAL

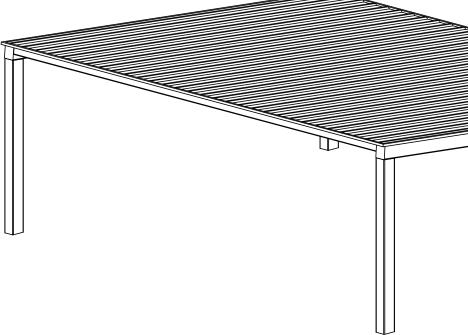


ALL WELD (AWS) CE ÒF AWS D

PARTS SH FABRICAT POSSIBLE


FOR PRO RECOMM ROOF INS EXPERIEN

FOR PRO RECOMM THROUGH ERECTED


	©		by PORTER CORP FIELD SUPPORT: (616) 888-3500
	DRAWN BY: Chris.lisac A	scale: 1:64	-
	PRINT DATE: 12/21/2023	:ON BOL	CAD MODEL: MSL-26X30
DING IS PERFORMED BY AMERICAN WELDING SOCIETY RTIFIED WELDERS AND CONFORMS TO THE LATEST EDITION D1.1 OR D1.3 AS REQUIRED. HOWN MAY BE UPGRADED DUE TO STANDARDIZED TION. REFER TO THE SHIPPING BILL OF MATERIALS FOR E SUBSTITUTIONS. PER FIELD INSTALLATION OF THE BUILDING IT IS ENDED THAT THE PRIMARY FRAME INSTALLER AND THE STALLER HAVE A MINIMUM FIVE (5) YEARS DOCUMENTED NCE INSTALLING THIS TYPE OF PRODUCT. PER FIELD INSTALLATION OF THE BUILDING IT IS ENDED THAT ELECTRIC WIRING, IF REQUIRED, BE RUN H THE STRUCTURAL MEMBERS BEFORE THE BUILDING IS	PROJECT:	PROJECT LOCATION:	DRAWING: COVER SHEET

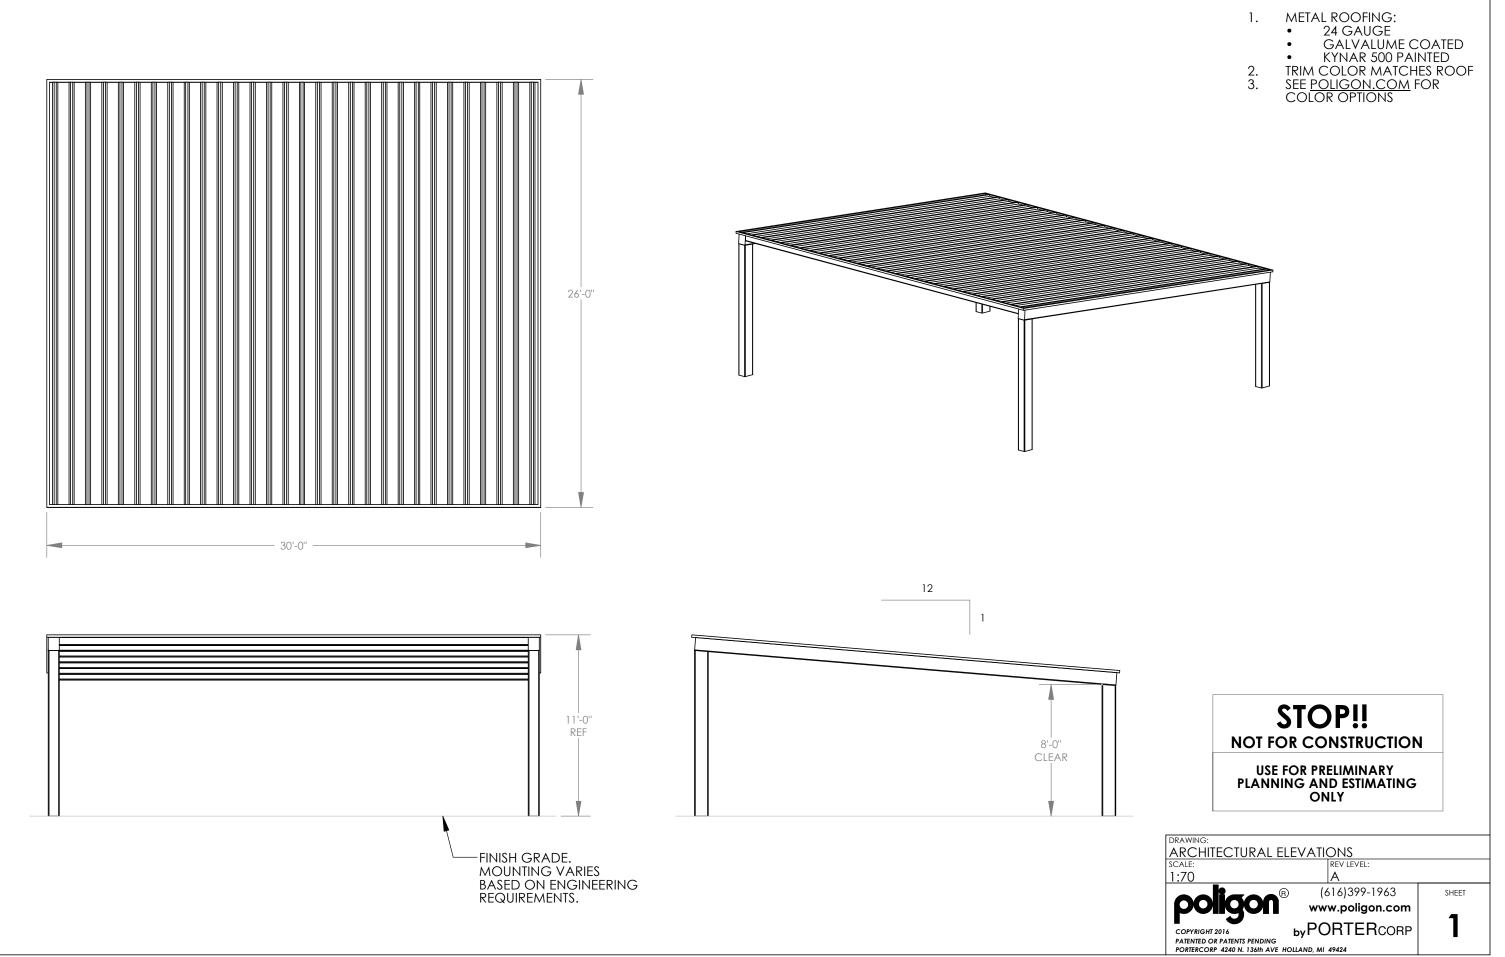

GENERAL ROOF NOTES:

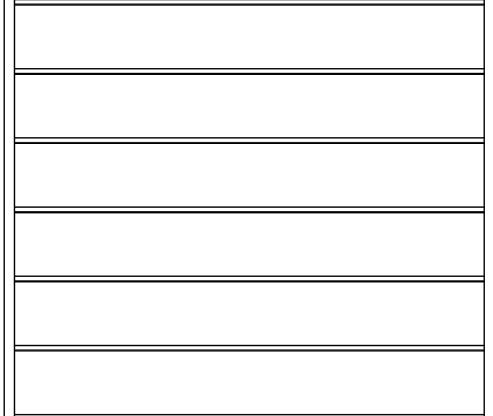




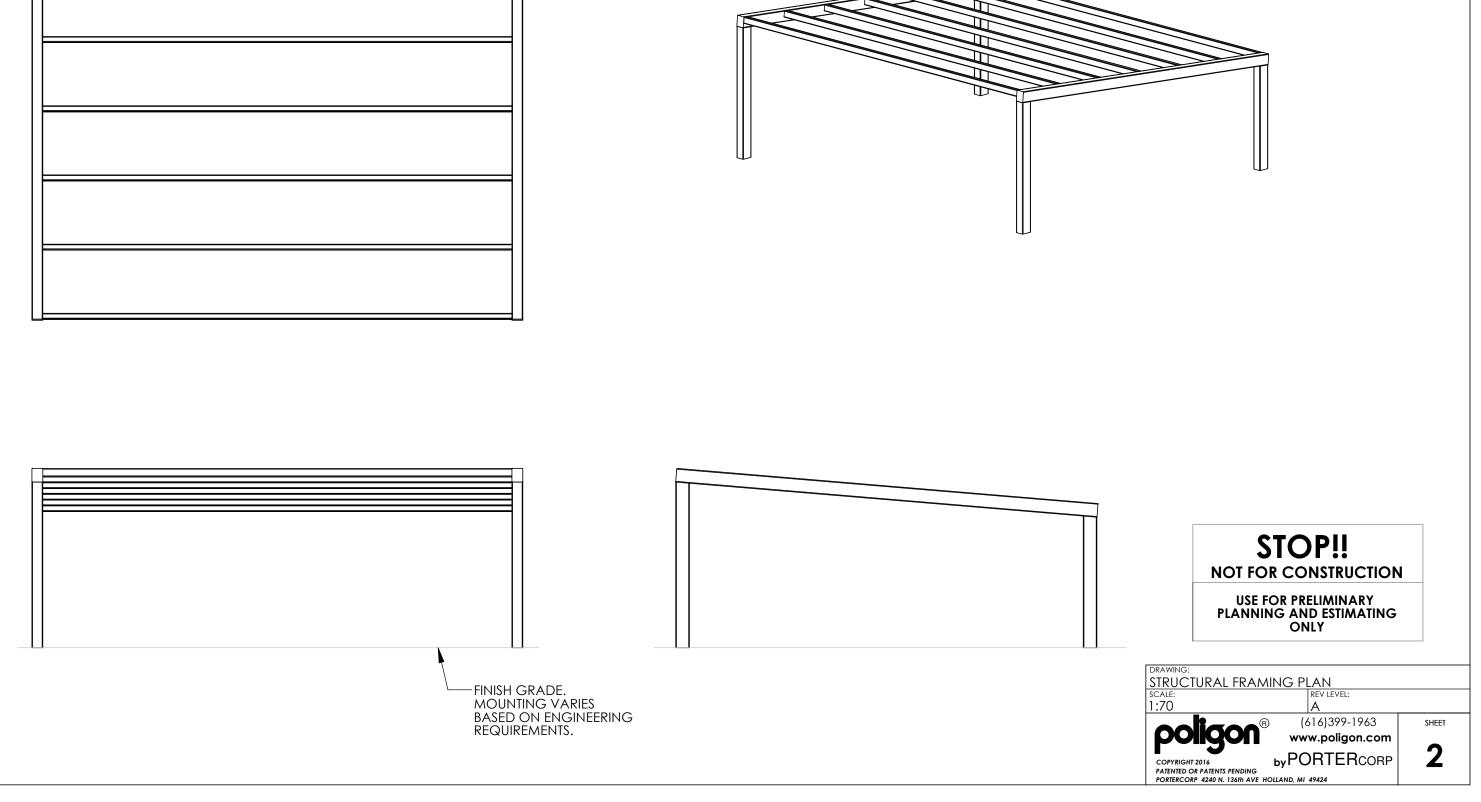


BASEPLATE NOTES:

- 1.

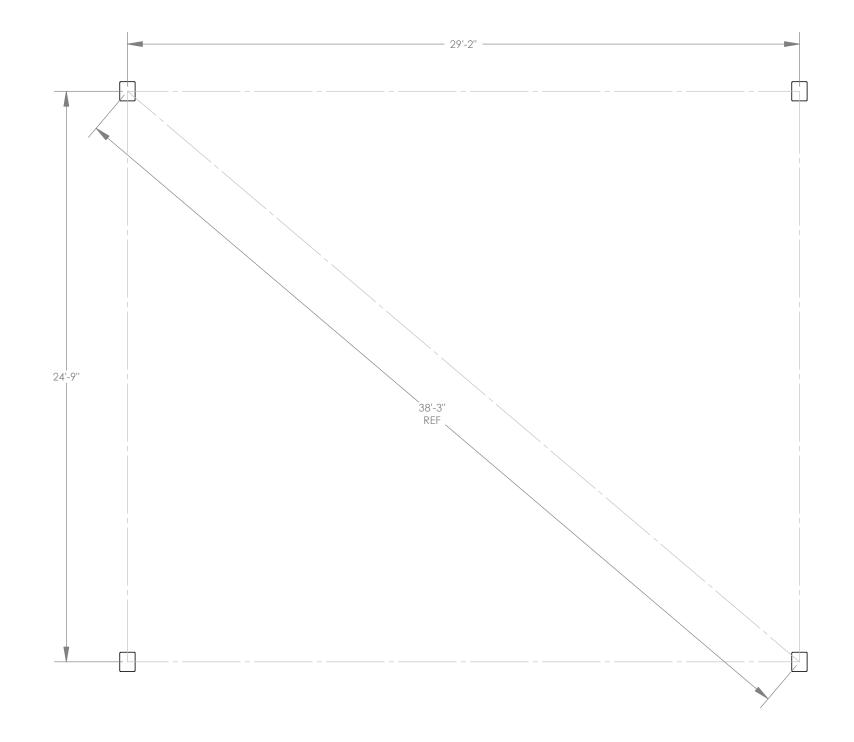

POLIGON ENGINEERING WILL DETERMINE REQUIRED BASEPLATE DESIGN AFTER ENGINEERING PACKAGE IS ORDERED. 2. CUSTOMER MAY SUGGEST PREFERRED BASEPLATE DESIGN.

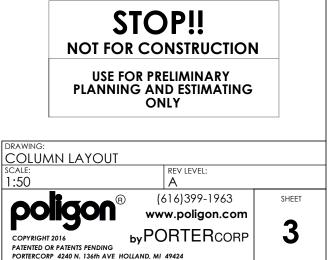

poligon®

FRAME COLOR: SURREY BEIGE ROOF COLOR: EVERGREEN COLORS SHOWN FOR ILLUSTRATIVE PURPOSES ONLY. FOR OTHER COLOR SELECTIONS, PLEASE SUBMIT AN E1 DRAWING REQUEST.

